#### **ZONING CHART**

ZONING DISTRICTS REGULATION TABLE CAMBRIDGE, MASSACHUSETTS

134 OXFORD LOT AREA 2,160 SQ. FT 136 OXFORD LOT AREA 2,816 SQ. FT **TOTAL LOT AREA 4,949 SQ.FT** 

#### **EXISTING**

RESIDENTIAL UNITS (6) EACH UNIT AREA LOWER FLOOR AREA 851 SF APPROX. TOTAL 1,702 SF FIRST FLOOR AREA 851 SF APPROX. TOTAL 1.702 SF SECOND FLOOR AREA 851 SF APPROX. TOTAL 1,702 SF THIRD FLOOR AREA 851 SF APPROX. TOTAL 1,702 SF

NOT SPRINKLERS

#### **CODE SUMMARY**

MULTIFAMILY DWELLINGS

EXISTING 3 STORIES AND BASEMENT **BUILDING TYPE: R3** 

**CONSTRUCTION TYPE: 5B** 

#### **GENERAL NOTES**

1. THE CONTRACTOR IS RESPONSIBLE FOR OBTAINING AND PAYING FOR ALL PERMITS REQUIRED FOR THIS PROJECT. ALL WORK SHALL COMPLY WITH THE MASSACHUSETTS STATE BUILDING CODE, 9TH EDITION.

2. THE CONTRACTOR IS SOLELY RESPONSIBLE FOR MEANS, METHODS TECHNIQUES, SEQUENCING, SCHEDULING AND SAFETY FOR THIS PROJECT.

3. ALL WORK SHALL BE PERFORMED IN CONFORMANCE TO THE MASSACHUSETTS STATE

4. THE CONTRACTOR SHALL VISIT THE SITE AND BE THOROUGHLY

ACQUAINTED BUILDING CODE AND ALL OTHER APPLICABLE CODES AND LAWS.

WITH THE PROJECT PRIOR TO SUBMITTING A PRICE. ADDITIONAL MONBE GRANTED FOR WORK NOT CLARIFIED PRIOR TO BIDDING.

5. THE CONTRACTOR SHALL REPORT ANY DISCREPANCIES BETWEEN DRAWINGS SPECIFICATIONS OR FIELD CONDITIONS TO THE ARCHITECT IMMEDIATELY.

6. THE CONTRACTOR IS RESPONSIBLE FOR REPAIRING ANY WORK DAMAGED BY HIS FORCES WHILE PERFORMING THIS CONTRACT.

7. THE CONTRACTOR SHALL WARRANTEE HIS WORK FOR A PERIOD OF ONE YEAR FROM THE DATE OF FINAL COMPLETION.

#### **WOOD NOTES:**

- ALL LUMBER SHALL HAVE A MOISTURE CONTENT OF NOMORE THAN 19%.
- ALL FRAMING LUMBER SHALL BE #2 HEM-FIR, OR BETTER, HAVING A MINIMUM: FB=1,200 PSI, FV=70 PSI, E=1,300,000 PSI.
- ALL L.V.L. LUMBER DENOTED ON PLANS SHALL HAVE A MINIMUM: AND NOT MORE THAN 8'-0" O.C.
- ALL JOIST SPANS SHALL HAVE ONE ROW OF 1" X 3: CROSS BRIDGING AT MID SPAN
- AND NOT MORE THAN 8'-O" O.C. ALL STUD BEARING WALLS SHALL HAVE ONE ROW OF 2X HORIZONTAL BLOCKING AT
- 1/2 STUD HEIGHT, AND NOT MORE THAN 6'-O" O.C. MAXIMUM. 6. PROVIDE AND INSTALL ALL NECESSARY TIMBER CONNECTORS WITH ADEQUATE STRENGTH.
- 7. PROVIDE DOUBLE JOIST BELOW PARTITIONS PARALLEL TOJOIST FRAMING.
- PROVIDE SOLID BRIDGING BELOW PARTITIONS PERPENDICULAR TO JOIST FRAMING.
- PROVIDE SOLID BRIDGING BETWEEN JOIST FRAMING MEMBERS WHEN BEARING ON STUD PARTITIONS OR BEAMS.
- 10. PROVIDE A CONTINUOUS BAND JOIST AT EXTERIOR STUD WALLS.
- 11. PROVIDE DIAGONAL METAL STRAP BRACING AT ALCORNERS AND WALL INTERSECTIONS, AT THE INSIDE FACE OF STUDS, FROM TOPLATE TO FLOOR PLATE AT 45°, SIMPSON TYPE "CWB", OR EQUAL.
- 12. ALL BUILT-UP BEAMS SHALL BE BOLTED WITH 1/2" DIAMETER BOLTS, MEETING A307 STANDARDS, OR, AS NOTED ON DRAWINGS.

#### **FOUNDATION NOTES:**

- 1. ALL FOUNDATION FOOTINGS SHALL BE CARRIED DOWN TO A MINIMUM OF 4'-0" BELOW FINISH GRADE, OR DEEPER, IF NECESSARY, TO OBTAIN A SAFE SOIL BEARING PRESSURE OF 2 TONS PER SQUARE FOOT, FOUNDATION DESIGN IS BASED ON ASSUMED SOIL BEARING CAPACITY OF 2 TONS PER SQUARE FOOT.
- 2. ALL CONCRETE SHALL ATTAIN A MINIMUM COMPRESSIVE STRENGTH OF 4,000 PSI.

**ZONING SOMERVILLE MA R-A** 

**ZONING CAMBRIDGE MA C-1** 

**RESIDENTIAL UNITS (6)** 

ADD SPRINKLER SYSTEMS

<u>PROPOSED</u>

AREA IN SOMERVILLE = 2,160 SQ. FT

AREA IN CAMBRIDGE = 2,117 SQ.FT

1. THE BASIC WIND SPEEDS FOR CAMBRIDGE / SOMERVILLE, MA IS 105 MPH

2. THE GROUND SNOW LOAD FOR CAMBRIDGE / SOMERVILLE, MA IS 45 PSF CMR MASSACHUSETTS STATE BUILDING CODE 9TH EDITION

#### **WOOD LINTEL SCHEDULE:**

Lintels over openings in bearing walls shall be as follows;

Or as noted on drawings.

Span of opening	ig: Size: 2x6 studs	Size: 2x4 stud
Less than 4'-0	" 3 - 2x4	2 - 2x4
Up to 6'-0"	3 - 2x6	2 - 2x6
Up to 8'-0"	3 - 2x8	2 - 2x8
Up to 10'-0"	3 - 2x10	2 - 2x10

#### **DESIGN LOADS:**

FLOORS - 40 P/S.F. (LIVE LOAD) ROOF - 50 P/S.F. DECK - 60 P/S.F.

#### **DEMOLITION NOTES**

- REFER TO GENERAL NOTES, DWG. T1.0 FOR ADDITIONAL COMMENTS REGARDING DEMOLITION AND REMOVALS.
- REMOVE EXISTING WALL TO EXTENT REQUIRED FOR NEW WORK.
- REMOVE EXISTING FINISHES, INCLUDING BUT NOT LIMITED TO: CARPET CERAMIC TILE, RESILIENT FLOORING, BASE AND WALL COVERINGS WHERE INDICATED AND AS REQUIRED. PREPARE SURFACES TO RECEIVE NEW FINISHES.
- REMOVE EXISTING CEILING, INCLUDING SUSPENSION SYSTEM WHERE INDICATED AND AS REQUIRED. PREPARE SURFACES TO RECIEVE NEW FINISHES.
- REMOVE EXISTING PARTITIONS AND ALL APPURTINANCES INCLUDING, BUT NOT LIMITED TO: DOORS, FRAMES, STANDING AND RUNNING TRIM, EQUIPMENT, ACCESSORIES AND CASEWORK. PATCH FLOOR, WALLS AND CEILINGS AS REQUIRED TO RECIEVE NEW FINISHES.
- REMOVE EXISTING DOOR AND ASSOCIATED HARDWARE.
- REMOVE EXISTING DOOR FRAME AND ASSOCIATED HARDWARE.
- REWORK EXISTING PLUMBING FITTINGS, REFER TO PLUMBING DRAWINGS FOR
- REMOVE/REWORK EXISTING SPRINKLER PIPING AND HEADS AS REQUIRED TO ACCOMODATE NEW LAYOUT.
- REMOVE EXISTING LIGHTING AND ASSOCIATED WIRING BACK TO PANEL AS REQUIRED FOR NEW LAYOUT.
- REMOVE EXISTING RUNNING TRACK INCLUDING CONCRETE UNDERLAYMENT AND RAMP. CARE SHOULD BE TAKEN TO PREVENT DAMAGE TO THE ORIGINAL SLAB. UNDER NO CIRCUMSTANCES SHOULD THE ORIGINAL SLAB BE CUT OR OTHERWISE
- REMOVE LOCKERS AND RELATED APPURTINANCES INCLUDING BUT NOT LIMITED TO BASE AND SPACERS.
- REMOVE LOCKERS AND RELATED APPURTINANCES INCLUDING BUT NOT LIMITED TO
- REMOVE TOPPING SLAB TO EXTENT REQUIRED FOR NEW PLUMBING. CARE SHOULD BE TAKEN TO PREVENT DAMAGE TO THE ORIGINAL SLAB. UNDER NO CIRCUMSTANCES SHOULD THE ORIGINAL SLAB BE CUT OR OTHERWISE PENETRATED.
- REMOVE RUBBER MATS. STORE FOR FUTURE USE.
- REMOVE RECEPTION DESK, RELATED CASEWORK AND HARDWARE. PATCH FLOOR AS REQUIRED TO RECIEVE NEW FINISHES.

Fax

e-mail

#### 134-136 OXFORD STREET



Front Elevation (Oxford St View) 12" = 1'-0"

#### **KEY SYMBOLS**

SMOKE DETECTOR

CO CARBON MONOXIDE DETECTOR

 $\bigcirc$ HEAT DETECTOR

EMERGENCY LIGHT

FE FIRE EXTINGUISHER

FACP FIRE ALARM CONTROL PANEL

**EMERGENCY EXIT** 

PULL STATION (HORN, STROBE, LIGHT)

VENT

WINDOW TYPE

SOLID POST 5"X5"

STEEL COLUMN 5"X5"

2 HOUR WALL (2"X6" TYP. WOOD STUD)

1 HOUR WALL(SEE W.T.1/A-3.1)

NEW INTERIOR WALL 2" x 6" (TYPICAL STUDS)

**EXISTING WALL** 

**EXISTING MASONRY WALL** 

WALL TO DEMOLISHED

RESIDENTIAL REMODEL

Owner: OXFORD REAL ESTATE **GROUP** 

134-136 OXFORD STREET CAMBRIDGE / SOMERVILLE, 02143

Consultant: Arthur Choo Sr (Structural Engineer) Address Phone



www.anzzadesign.com 375 High st # 2 Medford, MA 02155 Pho: 617-3724291

#### General Notes

Project number **Project Number** 10-10-2018 ANZZA DESIGN Drawn by Arthur Choo Sr. Checked by

Scale


As indicated



AREA IN SOMERVILLE=2832 SQ. FT. AREA IN CAMBRIDGE=2117 SQ. FT.

STREET

OXFORD

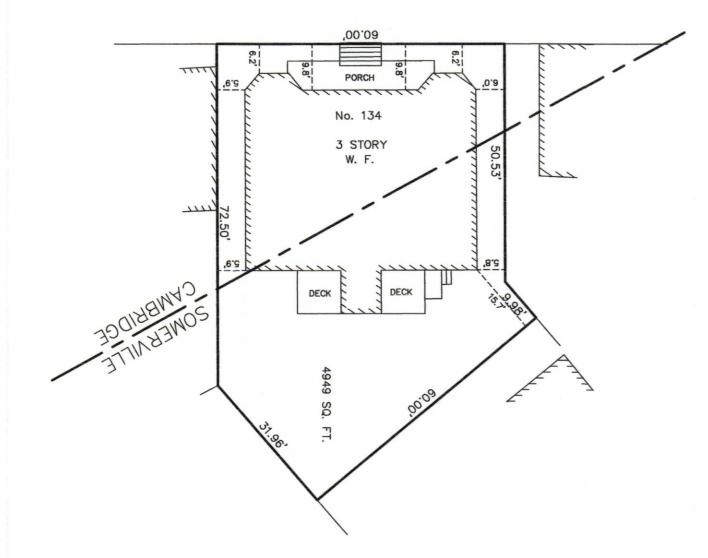



# PLOT PLAN

134 OXFORD STREET

SOMERVILLE,


MASS.

CAMBRIDGE

AGH ENGINEERING

AUGUST 24,

166 WATER STREET STOUGHTON, MA 02072 PHONE: (781)344—2386

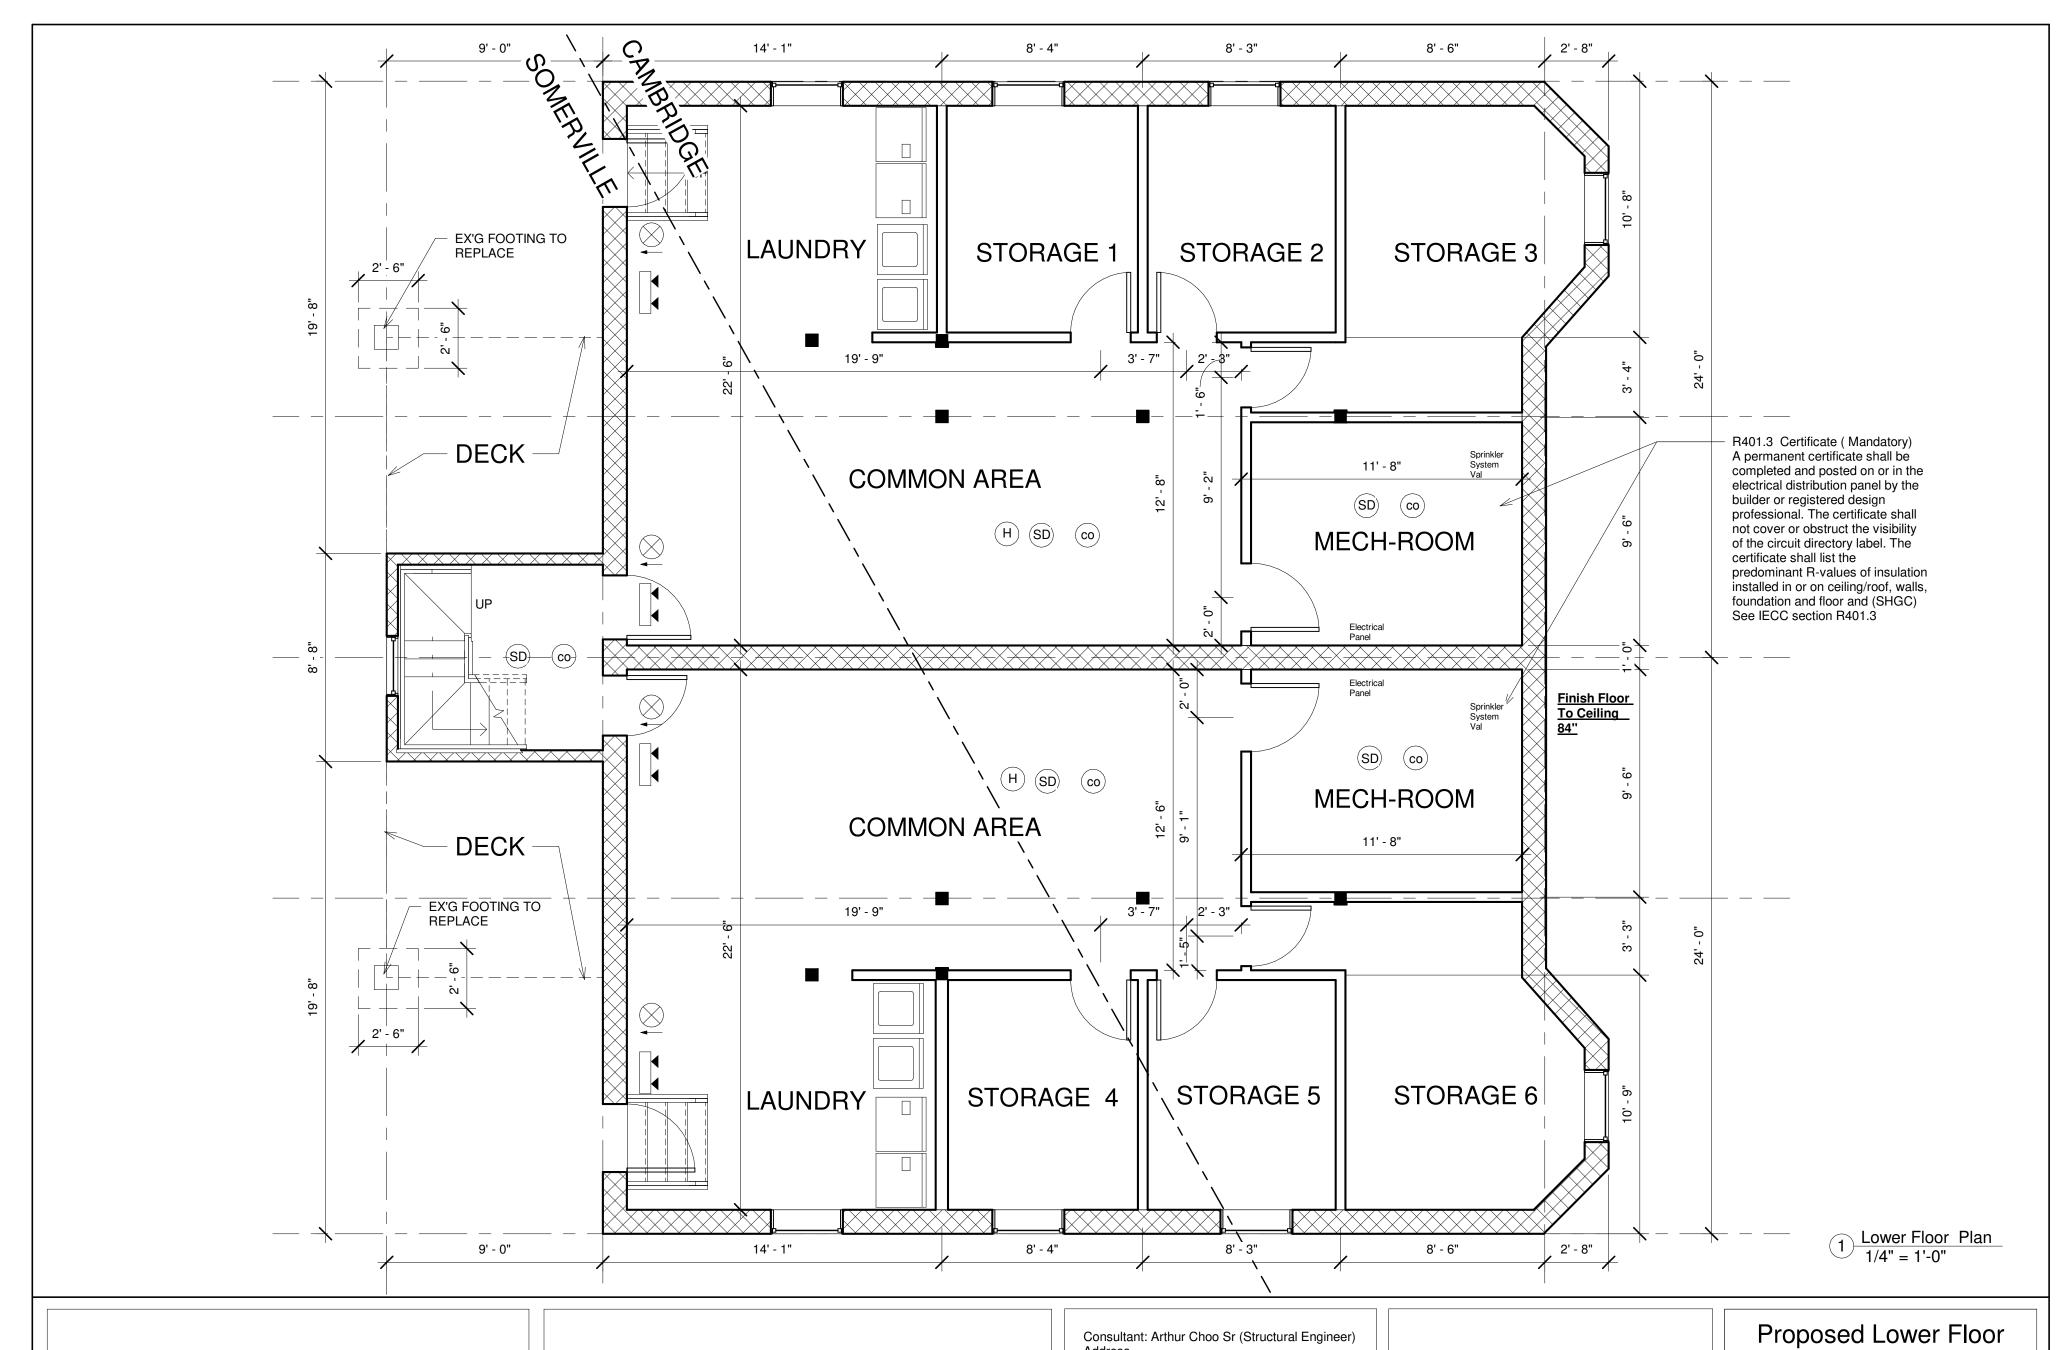

Owner: OXFORD REAL ESTATE GROUP

134-136 OXFORD STREET CAMBRIDGE / SOMERVILLE, 02143 MA

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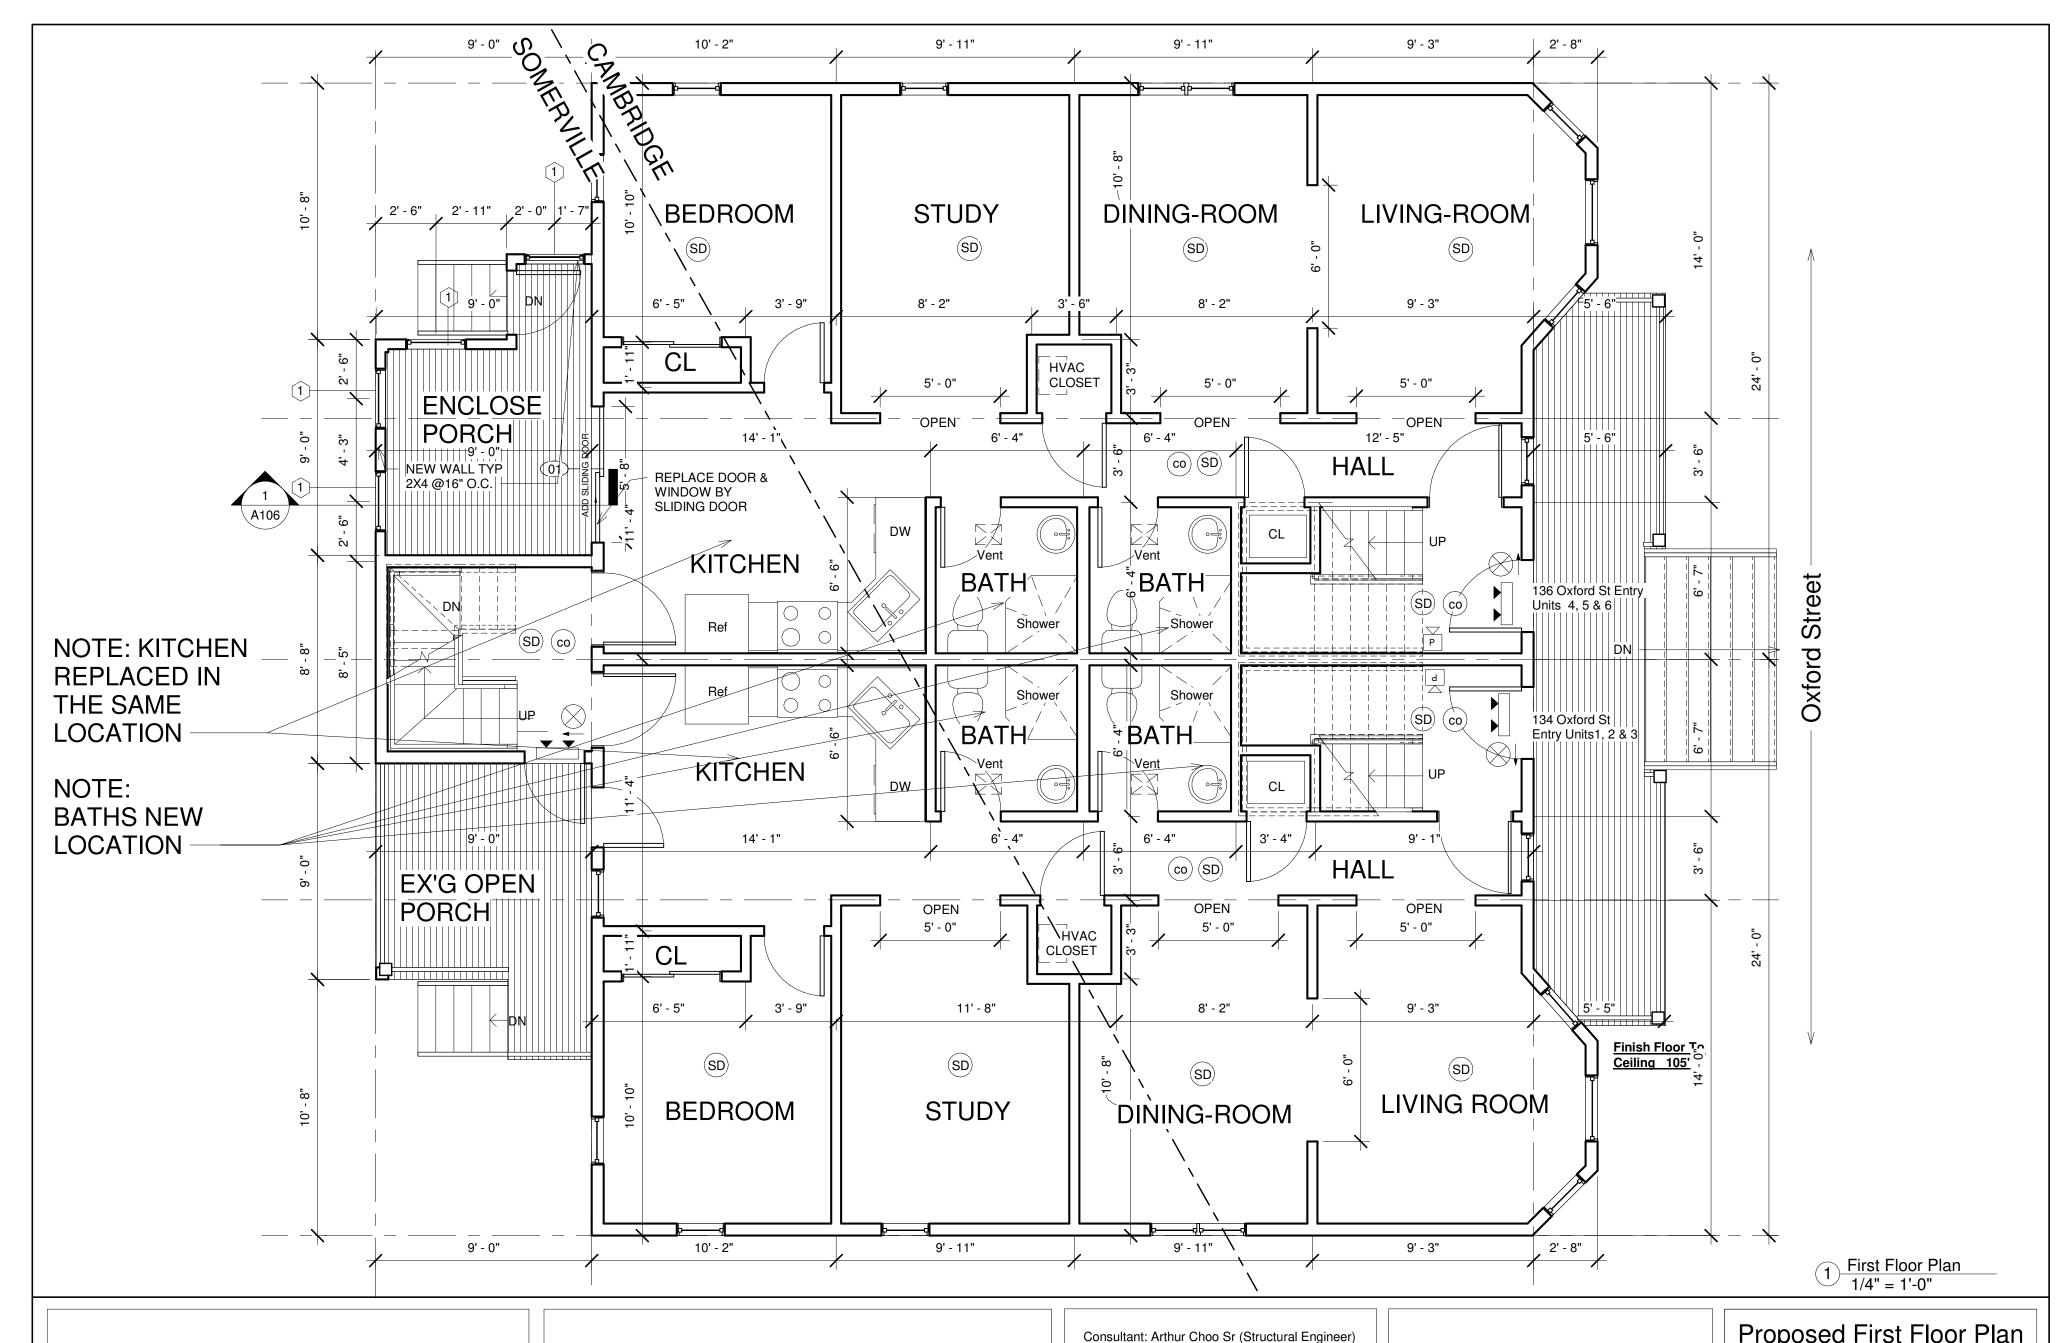
Designer www.anzzadesign.com 375 High st # 2 Medford, MA 02155 Pho: 617-3724291

# Plan

Project Number Project number 10-10-2018 Date ANZZA DESIGN Drawn by Arthur Choo Sr. Checked by

A101

1/4" = 1'-0" Scale



Owner: OXFORD REAL ESTATE **GROUP** 

134-136 OXFORD STREET CAMBRIDGE / SOMERVILLE, 02143 MA

Consultant: Arthur Choo Sr (Structural Engineer) Phone

Fax

e-mail



Designer www.anzzadesign.com

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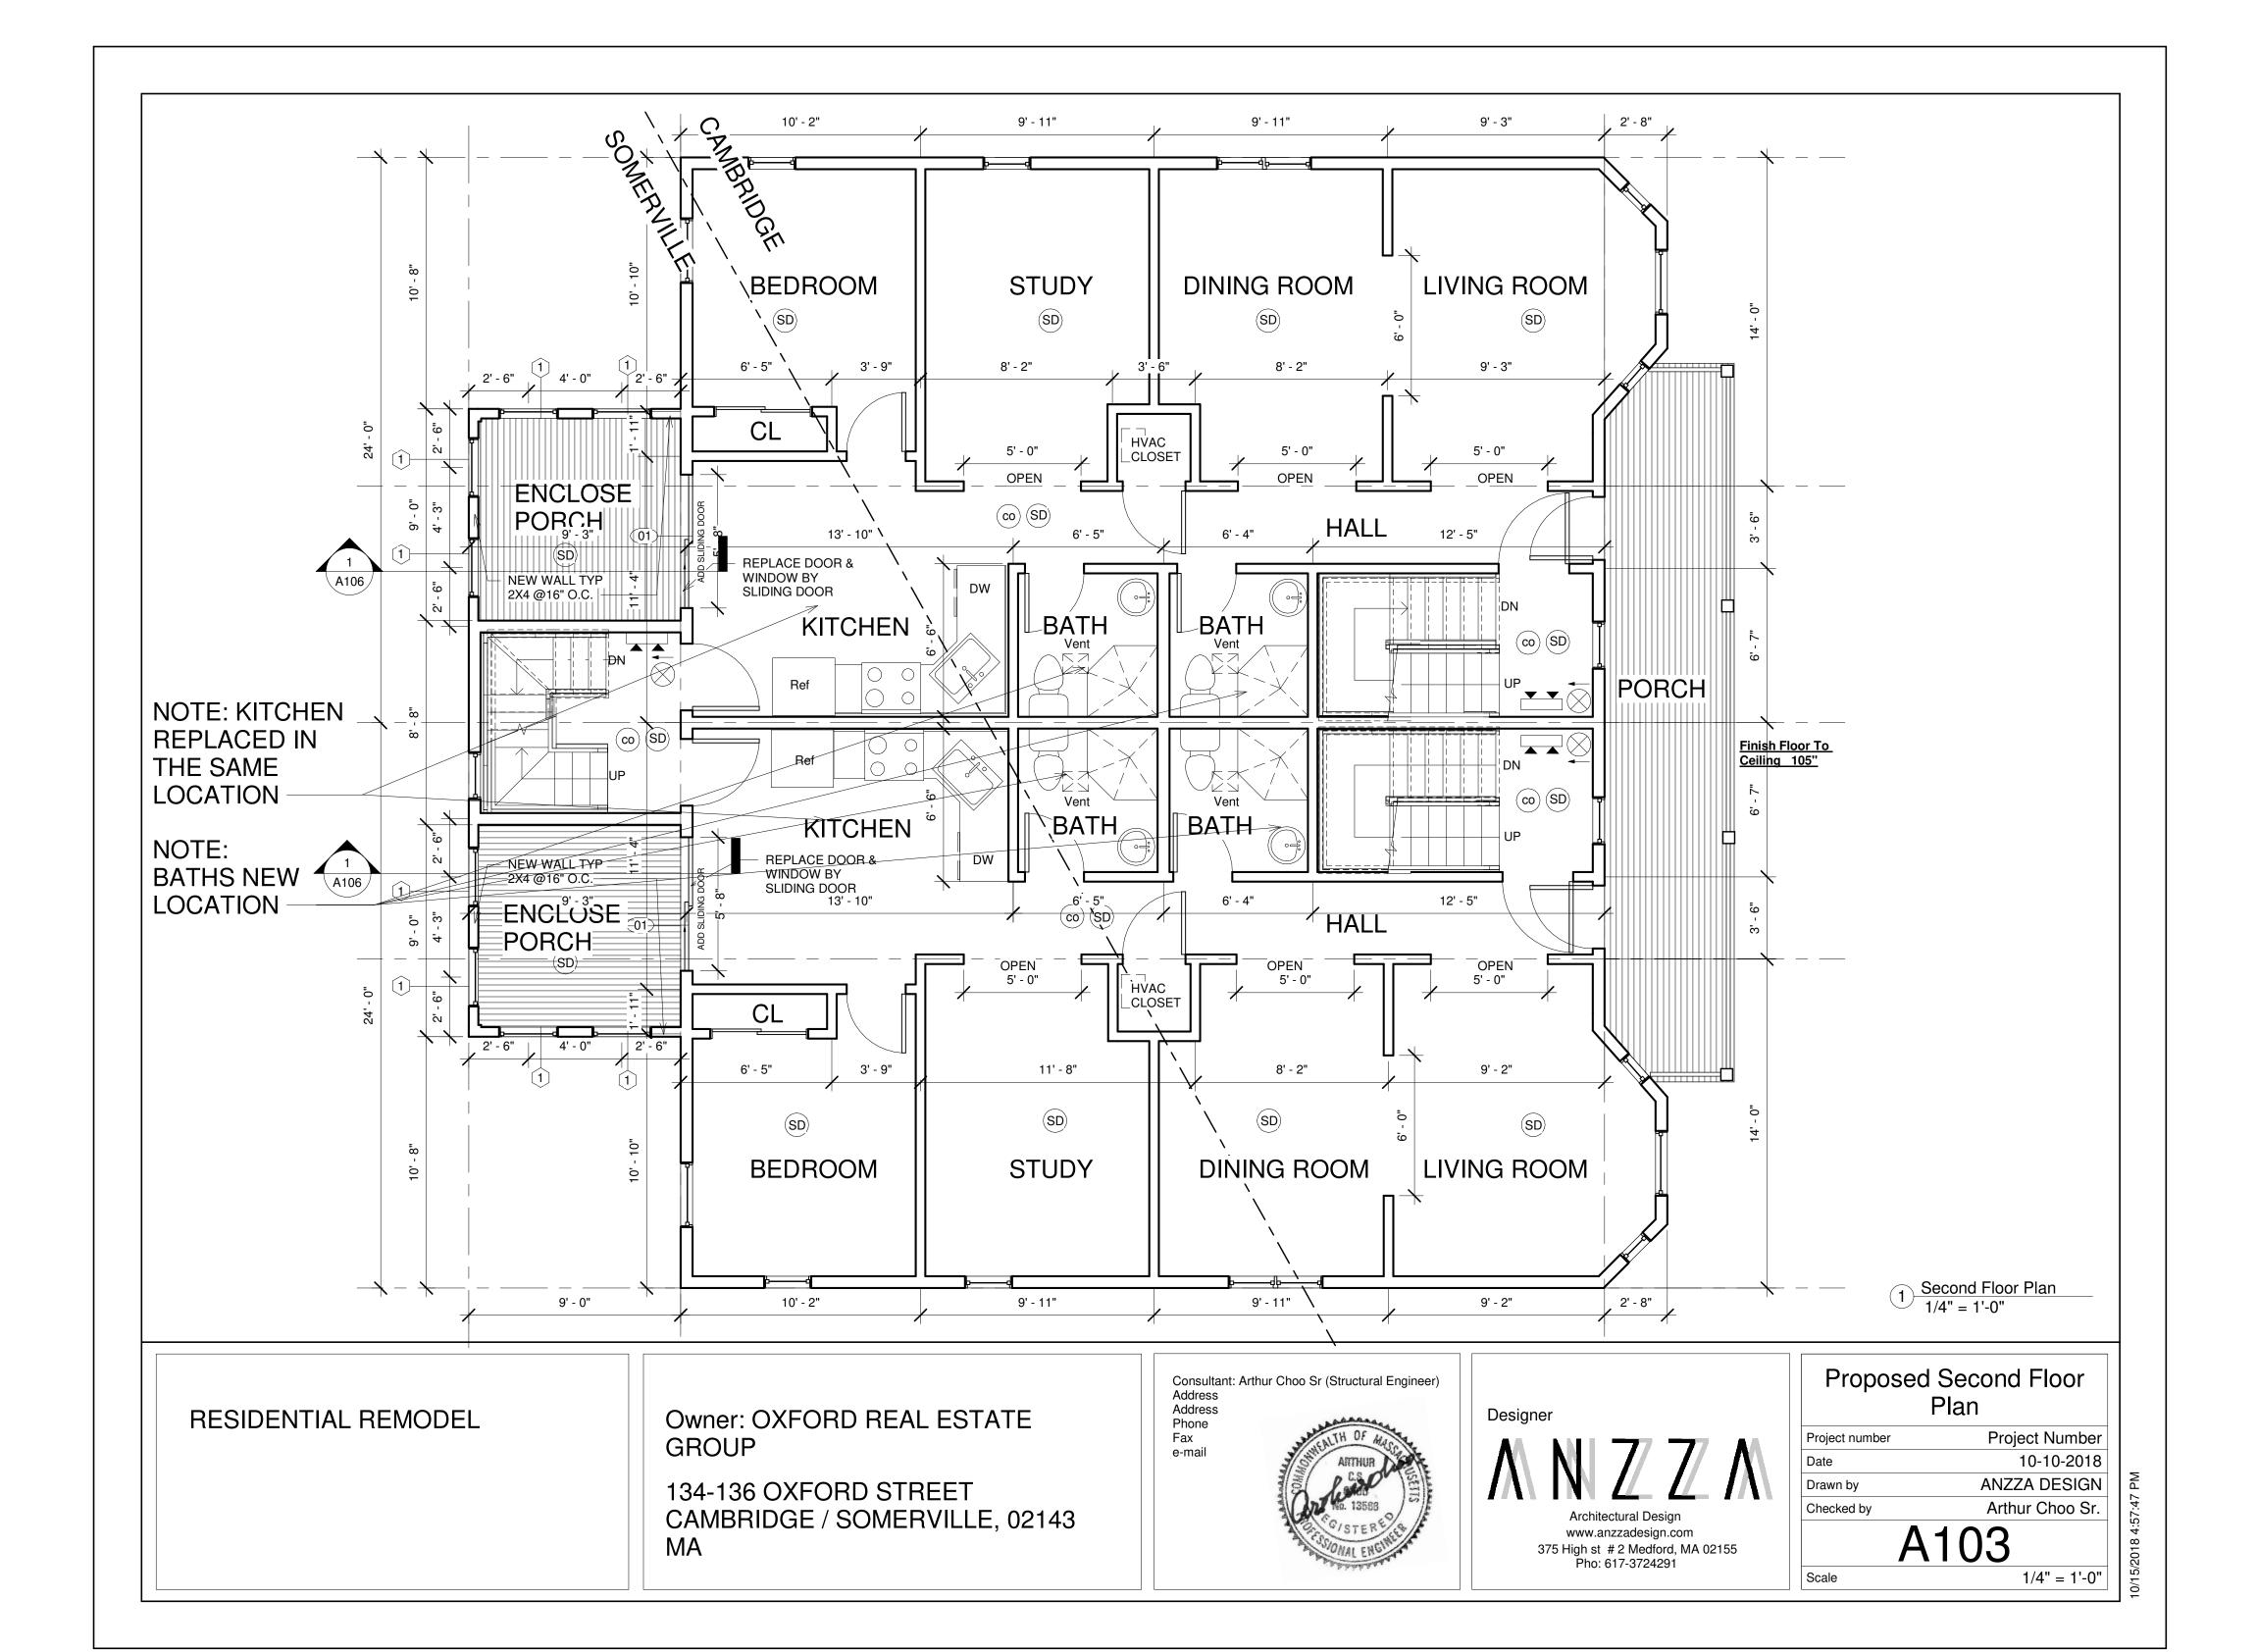
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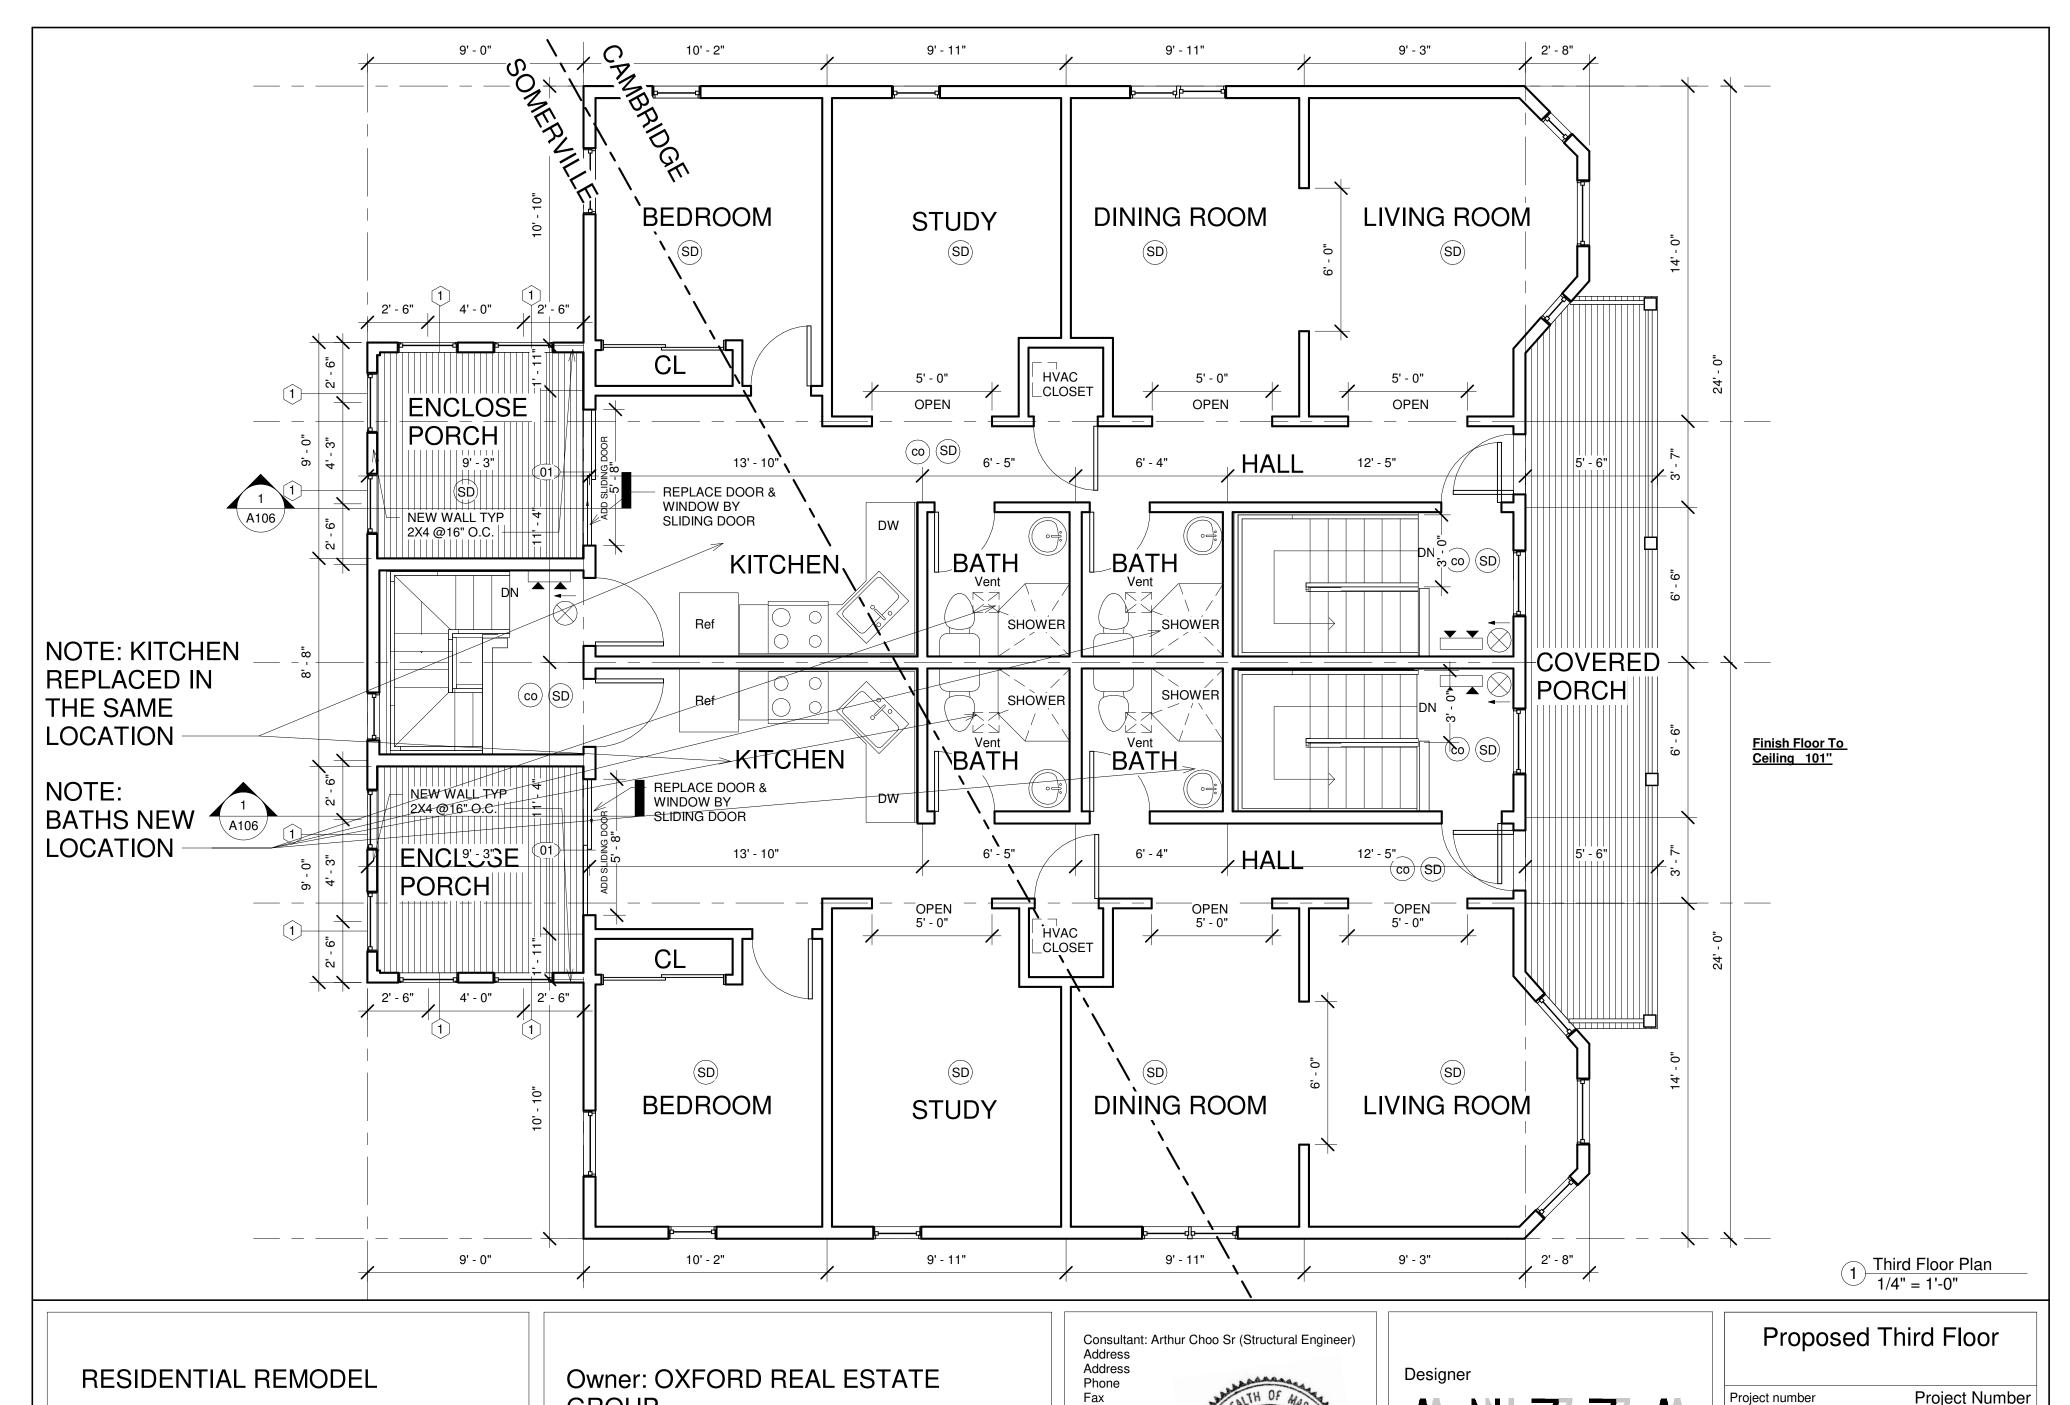
Project Number Project number 10-10-2018 Date Anzza Design Drawn by Arthur Choo Sr. Checked by

A102

Scale

1/4" = 1'-0"





**GROUP** 

134-136 OXFORD STREET CAMBRIDGE / SOMERVILLE, 02143 MA



e-mail


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Project Number 10-10-2018 Date Anzza Design Drawn by Arthur Choo Sr. Checked by

A104

Scale

1/4" = 1'-0"

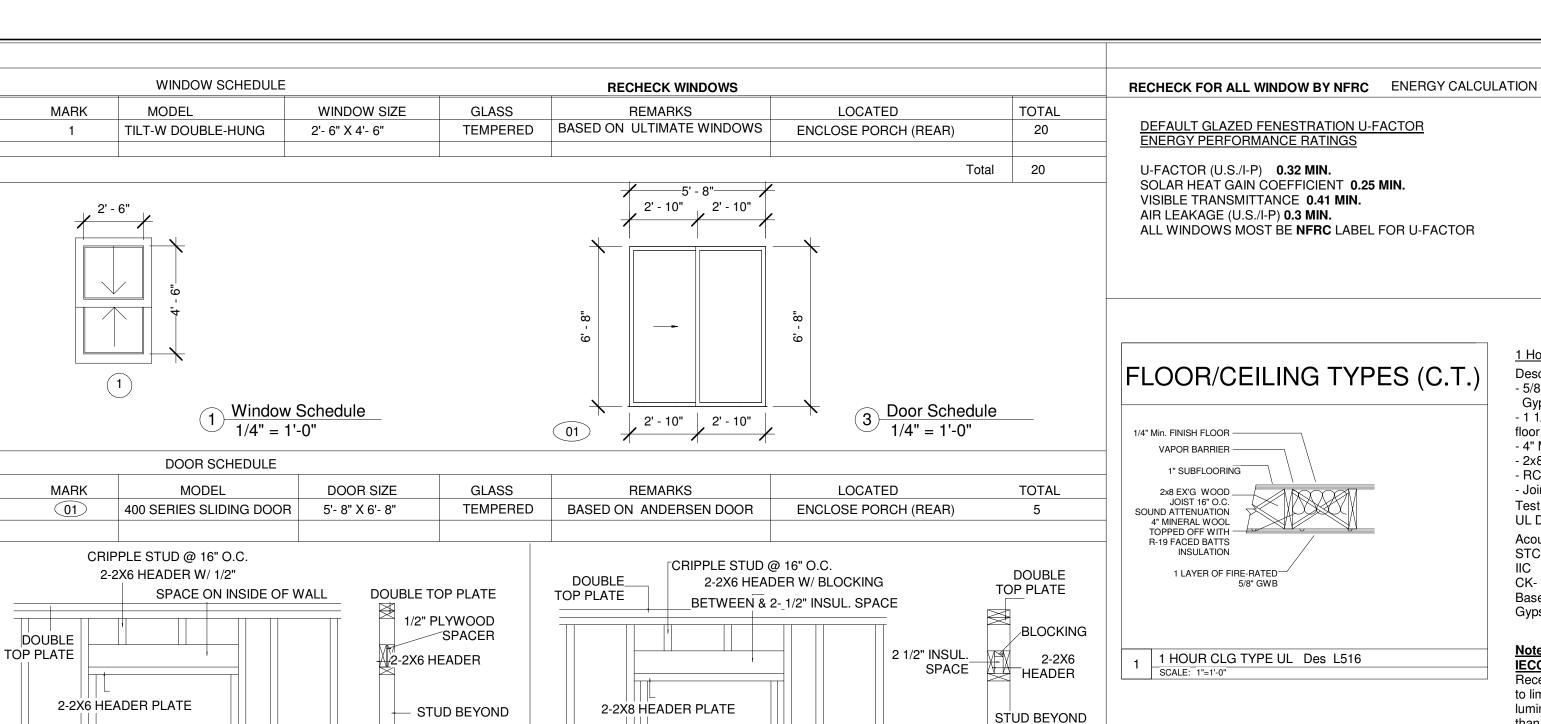

**DEFAULT GLAZED FENESTRATION U-FACTOR ENERGY PERFORMANCE RATINGS** U-FACTOR (U.S./I-P) 0.32 MIN. SOLAR HEAT GAIN COEFFICIENT 0.25 MIN. VISIBLE TRANSMITTANCE 0.41 MIN. AIR LEAKAGE (U.S./I-P) 0.3 MIN. ALL WINDOWS MOST BE **NFRC** LABEL FOR U-FACTOR

FLOOR/CEILING TYPES (C.T.) 1 LAYER OF FIRE-RATED-

DETAIL TO ALL FLOORS & CEILING

2 RAITNG 6" = 1'-0"

1 Hour Fire-Rated Construction Detail

Description

- 5/8" Sheetrock Fire C Code

Gypsum panels, ceiling. - 1 1/4" Nominal wood sub and finished

- 4" Mineral wool R-19 - 2x8 Ex'g wood joist 16" O.C.

 RC-1 channel or equivalent. - Joints finished.

Test Number UL Des L516

**Acoustical Performance** 

STC 50 to 54 Sound

CK- 6412-9

Based on 5/8" Sheetrock Firecode Core Gypsum Panels

**IECC R402.4.4** Recessed Lighting.

**CODE ENERGY** 

Recessed luminaries installed in the building thermal envelope shall be sealed to limit air leakage between conditioned and unconditioned spaces. All recesses luminaries shall be IC-rated and labeled as having an air leakage rate not more than 2.0 cfm (0.944 L/s) when tested in accordance with ASTM E 283 at a 1.57psf (75 Pa) pressure differential. All recessed luminaries shall be sealed with a gasket or caulk between the housing and the interior wall or ceiling covering.

**DEFAULT GLAZED FENESTRATION U-**

**ENERGY PERFORMANCE RATINGS** U-FACTOR (U.S./I-P) 0.32 MIN. VISIBLE TRANSMITTANCE 0.41 MIN. AIR LEAKAGE (U.S./I-P) 0.3 MIN.

**FACTOR** 

SOLAR HEAT GAIN COEFFICIENT 0.25 MIN. ALL WINDOWS MOST BE **NFRC** LABEL FOR **U-FACTOR** 

### Door & Window Framing Detal

STRETCH ENERGY CALCULATION

1/4" = 1'-0"

BASIC WIND SPEED TO CAMBRIDGE, MA 100 MPH

SUBFLOOR PLATE

STUD

DOOR

**OPENING** 

CLIMATE ZONE FENESTRATION U-F SKYLIGHT U-FACTOR CEILING R-FACTOR

CLIMATE ZONE FENESTRATION U-F GLAZED FENESTRATION

0.55

TRIMMER

DOOR ROUGH

**CLIMATE ZONES FOR MASSACHUSETTS** 

**PLATE** 

COMMON STUD

@ 16" O.C.

0.026

CEILING R-V

0.082

CRIPPLE STUD @ 16" O.C.

PLATE

MASS WALL U-FAC FLOOR U-FAC

MASS WALL R-VALUE FLOOR R-VALUE

0.033

STUD

SUBFLOOR

TRIMMER

OPENING

WINDOW ROUGH

**BY IECC 2012** 

FRAME WALL U-FAC

WOOD FM WALL R-V

0.057

20 0R 13+5

TABLE R 402 1.3 IECC 2014 **EQUIVALENT U-FACTORS** 

PLATE

WINDOW

OPENING

COMMON STUD

@ 16" O.C.

TABLE R 402 1. IECC 2014 **INSULATION AND FENESTRATION BY** 

COMPONENT

BASEMENT U-FACTOR CRAWL SPACE W U-FACTOR 0.050

15/19

BASEMENT R-V SLAB R-V CRAWL SPACE WALL R-V

STRETCH ENERGY CALCULATION

RESIDENTIAL REMODEL

1/4" = 1'-0"

5 A

Owner: OXFORD REAL ESTATE **GROUP** 

134-136 OXFORD STREET CAMBRIDGE / SOMERVILLE, 02143 MA

Consultant: Arthur Choo Sr (Structural Engineer) Address

10,2 FT

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#### 1ST FLOOR 2X8 CEILING 4" MINERAL WOOL TOPPED OFF WITH R- VALUE 19 FACED BATTS

BASEMENT EXTERIOR WALL 2X6 WALL BEHIND

FOUNDATION WALL 3" CLOSE CELL R- VALUE 19

2ND FLOOR EXTERIOR WALL 2X4 WALL 3 " CLOSE CELL R-VALUE 21

BASEMENT INTERIOR WALL 2X4 WALL 3" CLOSE CELL R- VALUE 19

1ST FLOOR EXTERIOR WALL 2X4 WALL 3 " CLOSE CELL R- VALUE 21

1ST FLOOR COMMON AREA WALL 2X4 WALL 3 " MINERAL WOOL

2ND FLOOR 2X12 ROOF RAFTERS 12" OPEN CELL R- VALUE 48

2ND FLOOR COMMON AREA 2X4 WALLS 3" MINERAL WOOL

2ND FLOOR 2X8 CEILING 4" MINERAL WOOL TOPPED OFF WITH R-VALUE 19 FACED BATTS

3RD FLOOR EXTERIOR WALL 2X4 WALL 3 " CLOSE CELL R-VALUE 21

3RD FLOOR 2X8 FLAT ROOF 12" MINERAL OPEN CELL R- VALUE 48


2ND FLOOR COMMON AREA 2X4 WALLS 3" MINERAL WOOL

### Window Schedule and Ceiling Rating Detail

**Project Number** Project number 10-10-2018 Anzza Design Drawn by Arthur Choo Sr. Checked by

Scale

As indicated

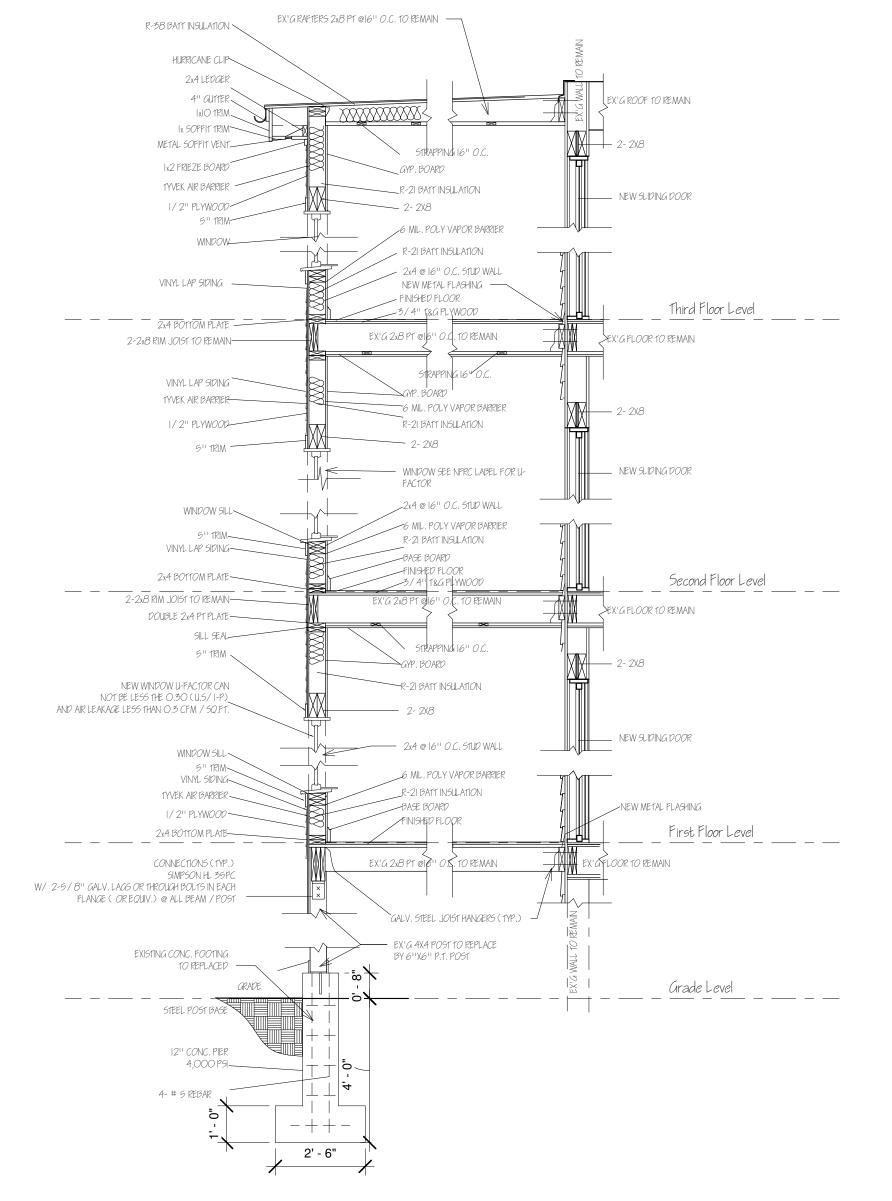

PROPOSE ENCLOSED PORCH



**EXISTING REAR PORCH** 

1 ENCLOSED PORCH WALL SECTION 3/8" = 1'-0"

RESIDENTIAL REMODEL

Owner: OXFORD REAL ESTATE GROUP

134-136 OXFORD STREET CAMBRIDGE / SOMERVILLE, 02143 MA Consultant: Arthur Choo Sr (Structural Engineer)
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## PORCH WALL SECTION ELEVATION DETAIL

Project number

Date

Drawn by

Checked by

Project Number

10-10-2018


Antinea Noguera


Arthur Choo Sr.

A106

Scale

3/8" = 1'-0"

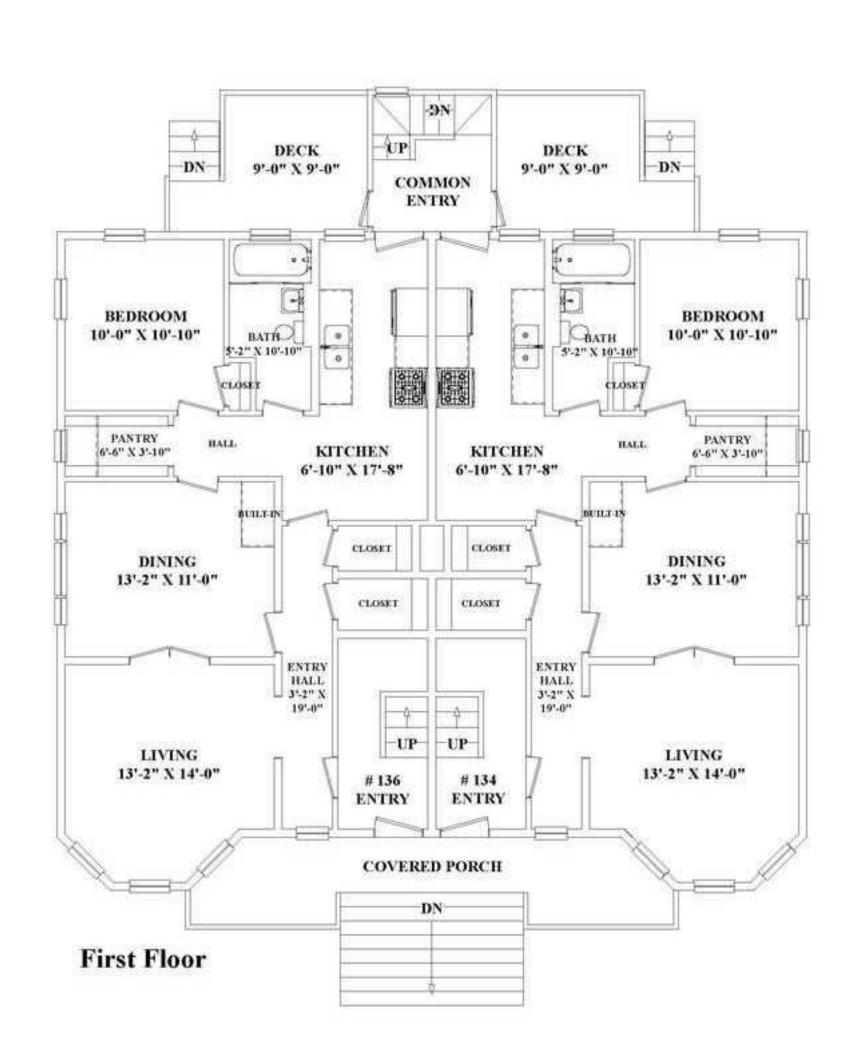

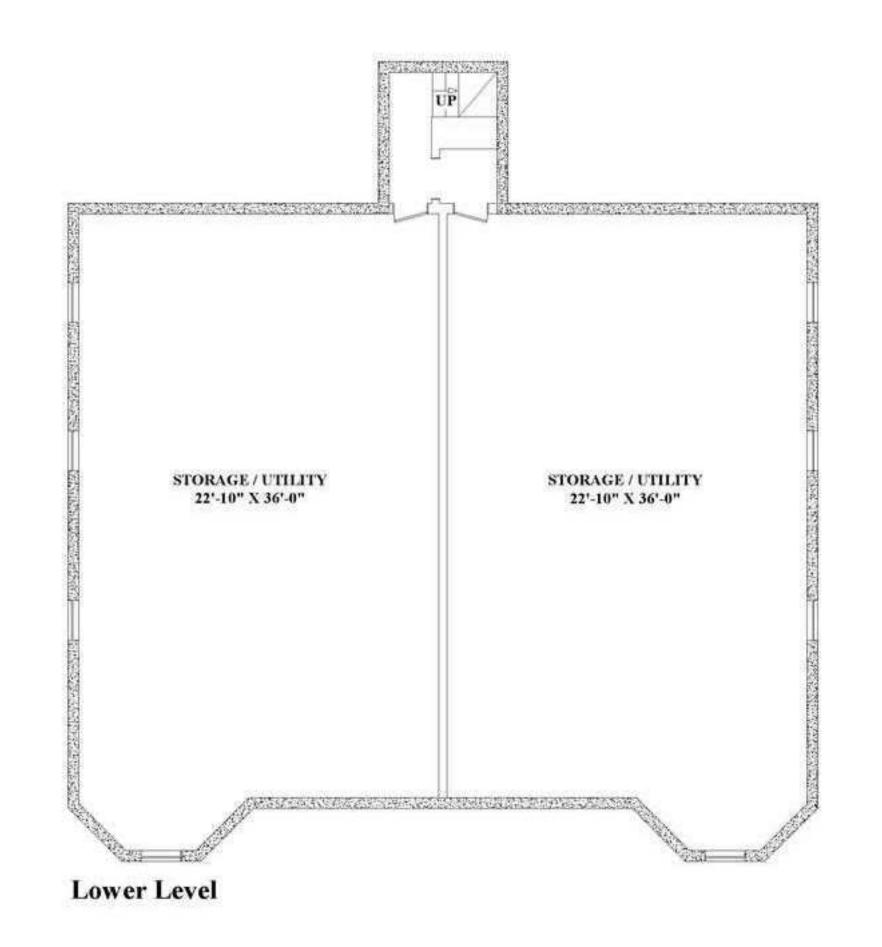

Owner: OXFORD REAL ESTATE GROUP

134-136 OXFORD STREET CAMBRIDGE / SOMERVILLE, 02143 MA Consultant: Arthur Choo Sr (Structural Engineer)
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# EXISTING LOWER & FIRST FLOOR PLAN

Project number

Scale

Project Number


Date 10-10-2018


Drawn by Antinea Noguera

Checked by Arthur Choo Sr

EX-101

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Owner: OXFORD REAL ESTATE GROUP

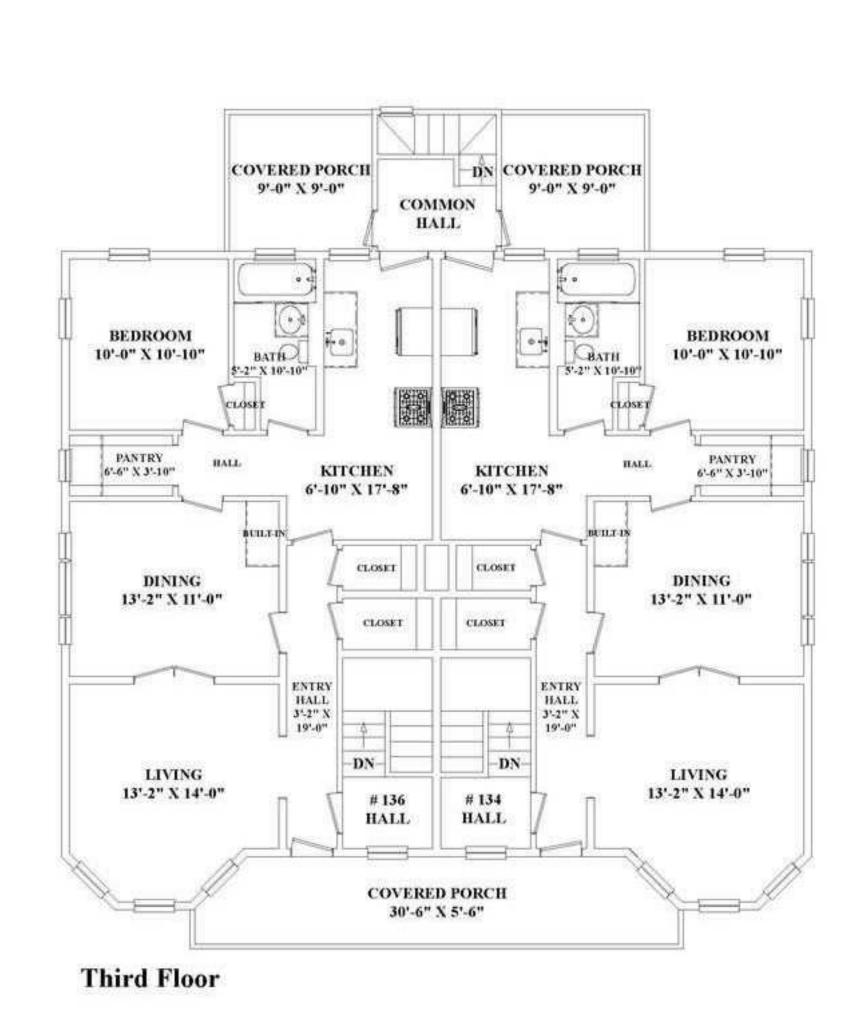134-136 OXFORD STREET CAMBRIDGE / SOMERVILLE, 02143 MA Consultant: Arthur Choo Sr (Structural Engineer)
Address
Address
Phone
Fax
e-mail

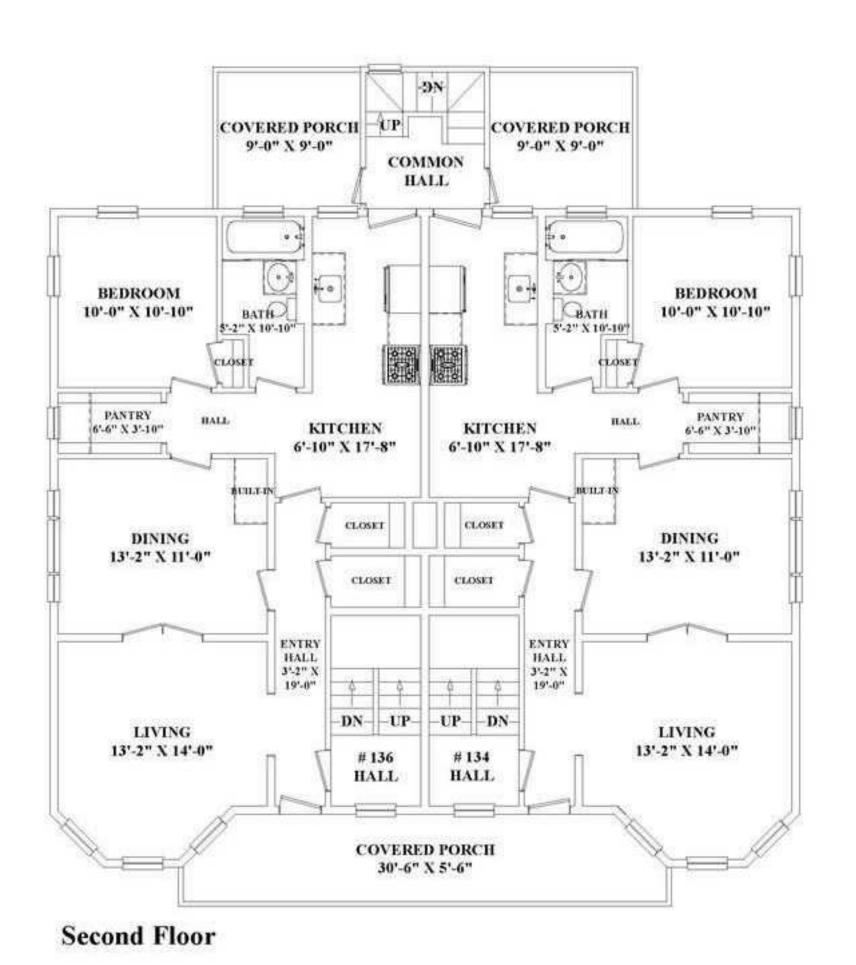Designer

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## EXISTING SECOND & THIRD FLOOR PLAN

Project number

Scale

Project Number

Date 10-10-2018

Drawn by Antinea Noguera

Checked by Arthur Choo Sr.

EX-102

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